



HOM BLOOMINGTON

Revisions	
Item	Date
PREIMMER WIT	
	<i>t</i> o
MINA RUE	

Registration Information

I hereby certify that this plan, specification, or report was prepared by me or under my direct supervision, and that I am a duly Licensed Architect under the laws of the State of Minnesota

Printed Name

Signature


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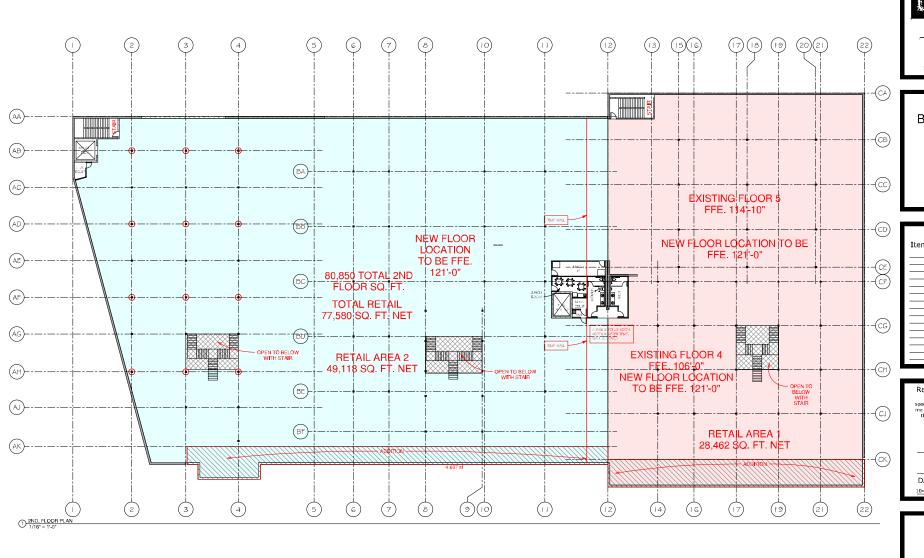
License #

10-13-15

16844

Sheet Information							
SITE PI	LAN						
Project No: 14-146	Drawing No :						
Drawn By : CAL							
Checked By : RT	AS1						
Date : 10-13-15							
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> HOM BLOOMINGTON

Revisions	:
Item	Date
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Registration Information

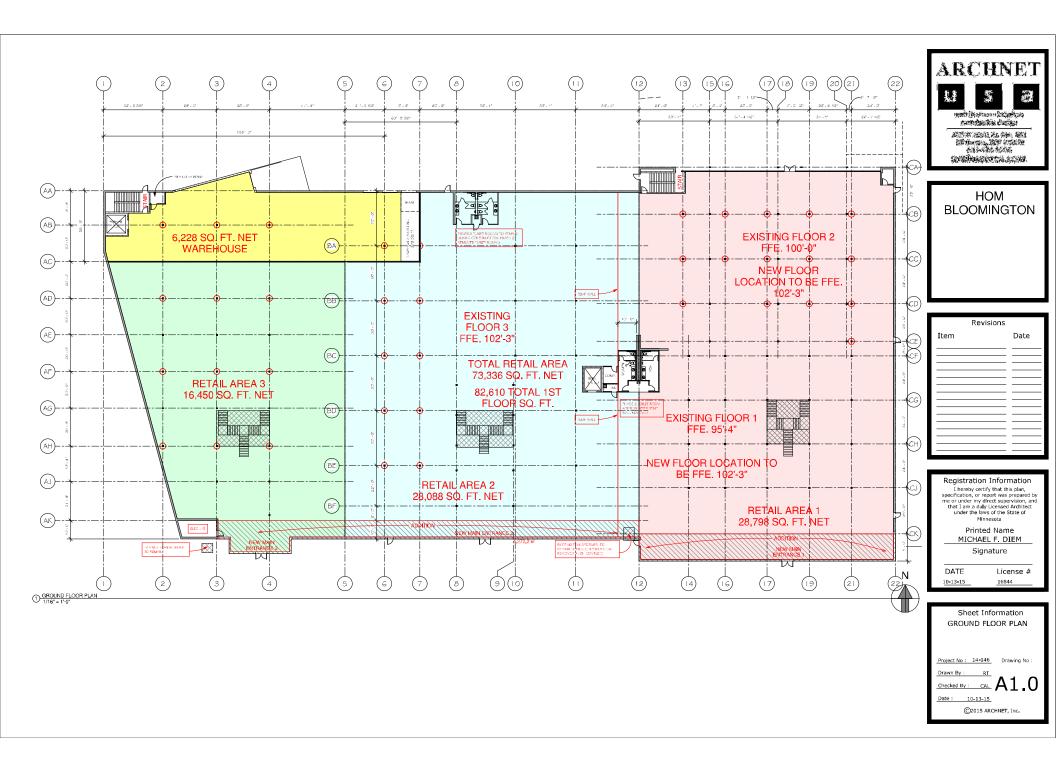I hereby certify that this glan,
specification, or report was prepared by
me or under my direct supervision, and
that I am a duly Ucensed Architect
under the laws of the State of
Minnesota

Printed Name
MICHAEL F. DIEM

Signature

DATE

License #
10-13-15


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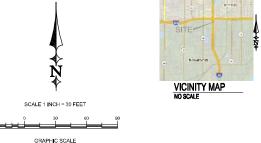
Sheet Information 2ND. FLOOR PLAN

Project No: 14-146 Drawing No: Drawing No: CAL. Checked By: Checker A1.1

Date: 10-13-15

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Keyed Notes

- (1) REMOVE EXISTING BITUMINOUS PAVEMENT AND BASE MATERIAL.
- (2) REMOVE EXISTING CONCRETE PAVEMENT AND BASE MATERIAL.
- SAW CUT BIT. EDGE PRIOR TO REMOVAL.
- REMOVE AND DISPOSE OF EXISTING MODULAR BLOCK WALL.
- REMOVE AND DISPOSE OF EXISTING METAL STAIRWAY
- TRANSFORMER AND GAS METER TO BE RELOCATED.
- OBLITERATE EXISTING STRIPING
- 8 EXISTING WALL/PORTION OF BUILDING TO BE REMOVED (SEE ARCHITECTURAL)
- (9) REMOVE AND DISPOSE OF EXISTING TREE
- (10) REMOVE AND DISPOSE OF CONCRETE CURB AND GUTTER
- 11) PYLON SIGN(S) TO BE REMOVED AND A NEW ONE INSTALLED (SEE ARCHITECTURAL DRAWINGS FOR NEW LOCATION)

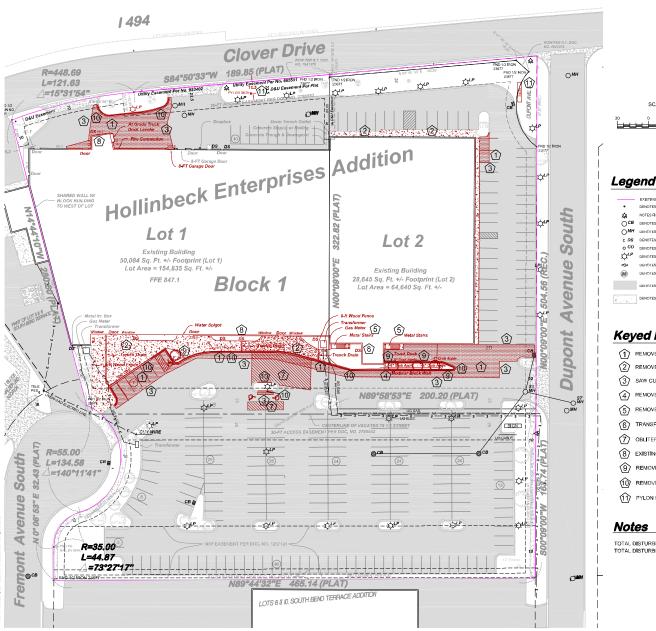TOTAL DISTURBED AREA = 16,540 SQ. FT < 1 ACRE (NPDES PERMIT NOT REQUIRED). TOTAL DISTURBED AREA = 16,540 SQ, FT > 5,000 SQ, FT (NINE MILE CREEK WATERSHED PERMIT REQUIRED) ERICKSON Civil

53 North Main Street, Saite 20 Seilbutter, Minnasota 55003 Phone (612) 309-3094

√ AGENCY REVIEW BID DOCUMENT

AS-BUILT DOCUMENT TODD A. ERICKSON, PE


40418 LICENSE NO 10/14/2015


HOM FURNITURE 10301 Woodcrest Drive NW Coon Rapids, Minnesota 55433

HOM FURNITURE 7800 Dupont Avenue South Bloomington, Minnesota

JOHNS. 15-123

SHEETTINE EXISTING CONDITIONS & DEMO PLAN SHEET NO.

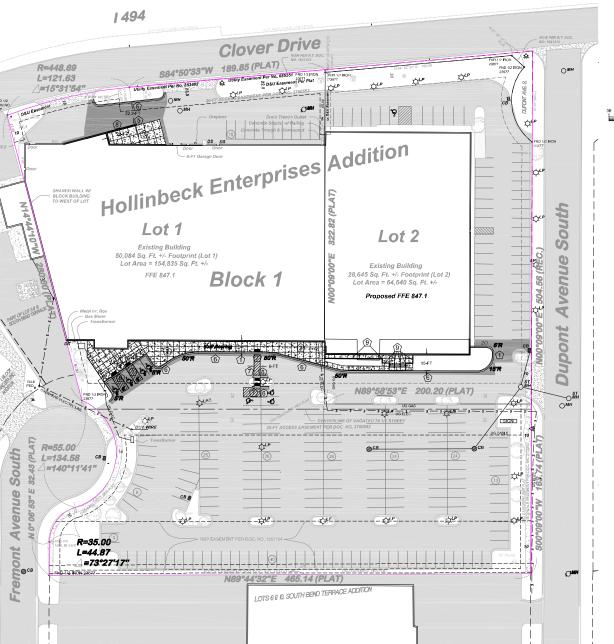

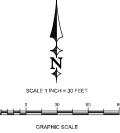

Legend

EXISTING PROPERTY BOUNDARY

PROPOSED CONCRETE SIDEWALK/LOADING AREA (SEE DETAILS 2/C4 & 3/C4)

PRÓPÓSED BITUMINOUS PAVEMENT (SEE DETAILS 1/C4 & 7/C4)



Layout Notes

1) ALL RADII TO BACK OF CURB

2) ALL DIMENSIONS TO THE FACE OF CURB UNLESS NOTED OTHERWISE

3) PAVEMENT STRIPING TO BE 4" VIDE WHITE PAINTED STRIPE. ACCESSBILE ACCESS ASLE STRIPING SHALL BE 4" WIDE WHITE PAINTED STRIPE 18" ON CENTER AND AT 45 DEGREE ANGLES TO STALL.

Keyed Notes

(1) INSTALL BITUMINOUS PAVEMENT, REFER TO DETAIL 1/C4.

(2) INSTALL CONCRETE SIDEWALK, REFER TO DETAIL 2/C4.

(3) INSTALL CONCRETE LOADING DOCK, REFER TO DETAIL 3/C4.

(4) INSTALL ADA PARKING SIGN, REFER TO DETAIL 4,C4.

(\$\frac{1}{3}\) INSTALL STEEL BOLLARD, 6" DIA. CONCRETE FILLED. 48" BELOW GRADE AND 42" ABOVE GRADE, INSTAL STANDARD YELLOW IDEAL SHIELD OVER TOP OF BOLLARD.

(6) INSTALL NEW 8612 CONCRETE CURB AND GUTTER, REFER TO DETAIL 5'C4.

(7) INSTALL NEW CONCRETE ADA RAMP, REFER TO DETAIL BIC4.

(8) INSTALL TV/O BAR SAFETY RAILING (GALVANIZED) ON TOP OF RETAINING WALL

(9) INSTALL BLACK POWDER COATED RAILING FOR STEPS, REFER TO DETAIL 7:C4.

(10) INSTALL HEAVY DUTY BIT, PAVEMENT SECTION, REFER TO DETAIL 1/C4.

(1) CURB IS FLAT FOR ENTIRE WIDTH OF STALLS.

Construction Specifications

1. THE CONTRACTOR SHALL COMPLY WITH ALL APPLICABLE PROVISIONS OF FEDERAL, STATE AND LOCAL SAFETY LAWS AND BUILDING CODES. ALL MORKMANSHIP SHALL COMPLY WITH THE OCCUPATIONAL SAFETY AND HEALTH ADMINISTRATION.

2. ALL FEES AND PERMITS SHALL BE THE RESPONSIBILITY OF THE INSTALLING CONTRACTOR UNLESS NOTED OTHERWISE

3, THE CONTRACTOR IS RESPONSIBLE FOR PROTECTING EXISTING BUILDING, UTILITIES, WALKS, CURB AND PAVEMENT FROM DAMAGE.

5. THE PORTLAND CEMENT FOR THE CONCRETE PAVEMENT SHALL CONFORM TO ASTN C-150 AND THE AGGREGATE SHALL 5. THE PORTLAND CEMENT FOR THE CONCRETE PAYEMENT SHALL CONFORM TO ASTIN C-150 AND THE AGGREGATE SHALL CONFORM TO ASTIN C-35. PLAN CONCRETE PAYEMENT SHALL BE CONSTRUCTED IN ACCORDANCE WITH MININESOTA DEPARTMENT OF TRAST CONCRETE PAYEMENT SHALL BE CASH CONCRETE AND SHALL BE A MIX OF PROPORTIONED FINE AND CONCRETE AND SHALL BE A MIX OF PROPORTIONED FINE AND CONCRETE AND SHALL BE A MIX OF PROPORTIONED FINE AND CONCRETE AND SHALL BE A MIX OF PROPORTIONED FINE AND CONCRETE AND SHALL BE A MIX OF PROPORTIONED FINE AND CONCRETE AND SHALL BE ADMINISTRATED FOR THE AGGREGATE. SLUMP FOR NORMAL WEIGHT CONCRETE SHALL BE A MANIMAN OF A INCHES AND A MIXIMAN OF A SHALL BE ADMINISTRATED FOR THE AGGREGATE. SHALL BE SHALL BE ADMINISTRATED FOR THE AGGREGATE SHALL BE ADMINISTRATED FOR THE AGGREGATE SHALL BE ADMINISTRATED FOR THE TRUCK DOLLY PAD AND 4,000 PSI FOR THE SIDEMYLANG A CUBB. ALL CONCRETE SHALL BE SHALL BE SUBMITTED TO ENGINEER FOR APPROVAL PRESENCE OF A SHALL BE SUBMITTED TO ENGINEER FOR APPROVAL PRESENCE OF SHALL BE SUBMITTED TO ENGINEER FOR APPROVAL. PRESENCE ASSET MESH DESCRIPTIONS.

THE CONCRETE PAVEMENT REQUIRES WELDING STEEL WIRE FABRIC CONFORMING TO ASTM A185. THE JOINT FILLER SHALL BE NON-EXTRUDING, PRE-MOLDED TYPE MEETING ASTM D-844, CONTRACTION JOINTS SHALL BE 1/4" (MIN. DEPTH OF 1/3 OF SLAB THICKNESS) TOOLED CONTROL JOINTS.

IT IS RECOMMENDED THAT THE CONTRACTOR NOTIFY DIGGERS HOT LINE AT 811 AT LEAST 72 HOURS PRIOR TO CONSTRUCTION.

9. THE CONTRACTOR SHALL OBTAIN ALL REQUIRED PERMITS ASSOCIATED WITH THE PROPOSED WORK

ERICKSON Civil

63 North Main Street, Suite 20 Stillmant, Minnesota 55063 Phone (612) 309-3894

√ AGENCY REVIEW

BID DOCUMENT AS BUILT DOCUMENT

TODO A. ERICKSON, PE

40418 LICENSE NO


10/14/2015


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JOHNS. 15-123 SHEET TITLE

LAYOUT PLAN



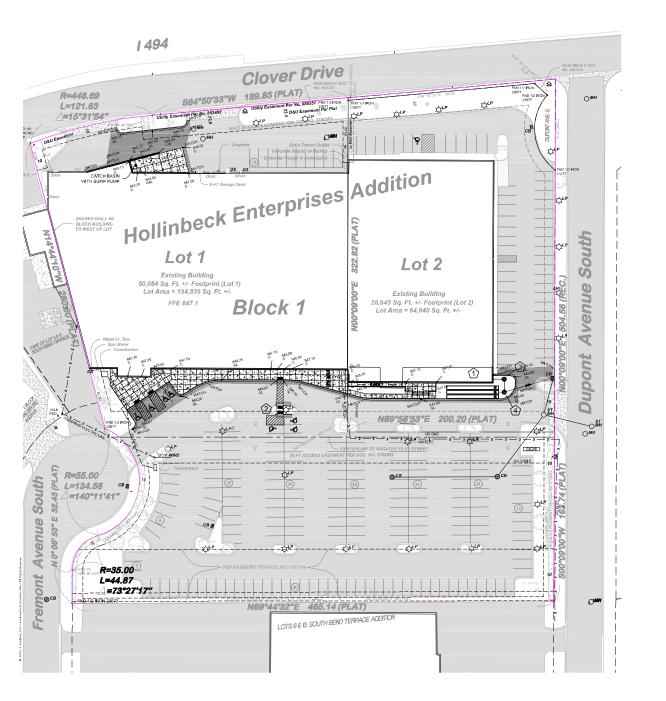

LEGEND

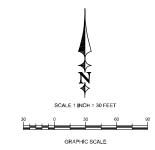GL = GUTTER LINE C = CONCRETE G = GROUND

PROPOSED STORM SEWER (SIZE INDICATED ON PLANS)

GRADING AND EROSION CONTROL NOTES

- SPOT ELEVATIONS ARE ALL GUTTER LINE OR FINISHED ELEVATION UNLESS
 NOTED OTHERWISE
- ELEVATIONS/CONTOURS SHOWN AS FINISHED GRADE ELEVATIONS. REFER TO GEOTECHNICAL REPORT FOR ADDITIONAL REQUIREMENTS.
- 3) DO NOT SPREAD TOPSOIL WHILE IT IS FROZEN OR MUDDY OR WHEN THE SUPPLICE SUBGRADE IS WET OR FROZEN. CORRECT ANY INTEGULARITIES IN THE SUPPLICE SUPPLICE AND THE SUPPLICE SUPP
- 5) CONTRACTOR SHALL SCHEDULE SOILS TESTING FOR EACH STRUCTURAL FILL AREA, PAD AND STREET AREA.
- PRIOR TO ROUGH GRADING, INSTALL BIO LOGS AND STORM INLET PROTECTION IN LOCATIONS SHOWN OR AS DIRECTED BY THE ENGINEER OR CITY STAFF.
- CONTRACTOR TO INSPECT AND DOCUMENT EROSION CONTROL A MINIMUM OF ONCE EVERY SEVEN DAYS AND WITHIN 24 HOURS OF ANY RAIN EVENT GREATER THAN 1/2 INCH IN 24 HOURS AND WITHIN SEVEN DAYS AFTER THAT EVENT.
- 8) BID LOG FOUND DAMAGED MUST BE REPAIRED OR REPLACED WIN 24 HOURS UPON DISCOVERY, REMOVAL OF FIBER ROLL AND SILT FENCE REQUIRED AFTER SITE IS STABILIZED (AT DIRECTION OF ENGINEER).
- ALL PUBLIC STREETS SHALL BE KEPT FREE OF SEDIMENT AND DEBRIS. ANY SEDIMENT OR DEBRIS DETECTED MUST BE REMOVED WITHIN 24 HOURS OR AS DIRECTED BY CITY.
- 10) ALL EXPOSED SOIL SHALL BE STABILIZED AS SOON AS POSSIBLE, BUT NO LATER THAN 7 DAYS AFTER CONSTRUCTION ACTIVITY HAS TEMPORARILY OR PERMANENTLY CEASED.
- 11) ALL PROPOSED AND EXISTING CATCH BASINS WITHIN PROJECT AREA SHALL BE PROVIDED INLET PROTECTION. REGULAR CLEANING OF PROTECTION SHALL OCCUR AND SHALL BE INCLUDED IN THE UNIT PRICE OF INLET PROTECTION.

NINE MILE CREEK REQUIREMENT

TOTAL DISTURBED AREA = 16,540 SQ. FT. X 1-INCH/12-FT = 1,378 CU. FT. OF INFILTRATION REQUIRED.

UNDERGROUND STORAGE

- CONTRACTOR SHALL INSTALL (3) ROWS OF 42" DIAMETER PERFORATED HDPE PIPING OVER 12" OF 1-1/2" ROCK PER DETAIL. REFER TO DETAIL 8/C4.
- 2) STRAIGHT GRADE FOR SIDEWALK THROUGH ISLAND.
- (3) 60° DIA. MANHOLE WITH 4-FT DEEP SUMP, RIM 843.5, INV. 840.50 (15 INCH PVC S,W), SUMP 836.50
- 60° DIA. MANHOLE WITH 4-FT DEEP SUMP, RIM 843.35, INV. 840.40 (16 INCH PVC N,E,W), SUMP 836.40



53 North Main Street, Suize 26 Stillwater, Minnesota 55052 Phone (612) 309-3004

√ AGENCY REVIEW BID DOCUMENT

AS-BUILT DOCUMENT TODO A ERICKSON, PE

40418 LICENSE NO 10/14/2015


HOM FURNITURE 10301 Woodcrest Drive NW Coon Rapids, Minnesota 55433

HOM FURNITURE 7800 Dupont Avenue South Bloomington, Minnesota

_{ловио.} 15-123

SHEET TITLE GRADING AND DRAINGE PLAN

1 BITUMINOUS PAVING SECTION(S) NO SCALE

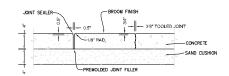

2 CONCRETE SIDEWALK DETAIL NO SCALE

NOTES: TOOLED JOINTS:

JOINT SPACING SHALL MATCH WALK WIDTH UNLESS SHOWN OTHERWISE ON PLANS.

EAPANSIUN JOINTS:

1) WHERE WALK BUTTS ANY FIXED OBJECT SUCH AS WALLS, CURBS, MAINOLES, ETC.

2) 45' ON CENTER MAXIMUM OR AS SHOWN ON PLANS.

3) JOINT SEARE SHALL MEET ASTM D-412, GRAY, SELF LEVELING, EPOXY, AS WITH "QUICKJOINT 300" OR EQUAL.



4 ADA SIGN AND POST

C4 NO SCALE

12"X18" (R7-128)

ALUMINUM SIGN

2.5 LBJFT FLANGED


CHANNEL SIGN POST (MNDOT 3401)


4° SCH, 40 STEEL PIPE FILL WITH CONC. PAINTED TRAFFIC YELLOW







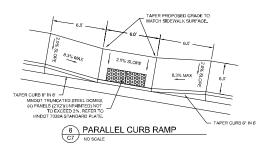


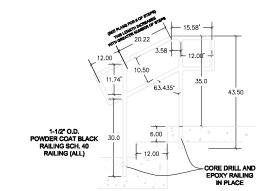

TYPICAL EXTERIOR RAILING DETAIL

C4 NO SCALE

Per Safety Rail Company: 4244 Shoreline Drive, Spring Park, MN 55384 Phone: 888-434-2720 | Fax: 888-471-4931 www.safetyrailcompany.com

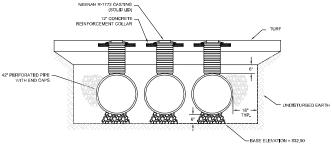

- 1. ALL REFERENCES TO CLASS FOR IT MATERIAL ARE PER ASTM D2321 "STANDARD PRACTICE FOR UNDERGROUND INSTALLATION OF THERMOPLASTIC PIPE FOR SEWERS AND OTHER GRAVITY FLOW APPLICATIONS", LATEST EDITION.
- 2. ALL RETENTION AND DETENTION SYSTEMS SHALL BE INSTALLED IN ACCORDANCE WITH ASTM D2321, LATEST EDITION AND THE MANUFACTURER'S PUBLISHED INSTALLATION GUIDELINES
- 3. MEASURES SHOULD BE TAKEN TO PREVENT THE MIGRATION OF NATIVE FINES INTO THE BACKFILL MATERIAL, WHEN REQUIRED. SEE ASTM D2321.
- 4. FILTER FABRIC: A GEOTEXTILE FABRIC MAY BE USED AS SPECIFIED BY THE ENGINEER TO PREVENT THE MIGRATION OF FINES FROM THE NATIVE SOIL INTO THE SELECTED BACKFILL MATERIAL.
- 5. <u>FOUNDATIONS</u>: WHERE THE TRENCH BOTTON IS UNSTABLE THE CONTRACTOR SMALL EXCAVATE TO A DEPTH REQUIRED BY THE ENGINEER AND REPLACE WITH SUITABLE MATERIAL AS SPECIFIED BY THE ENGINEER AS AN ALTERNATIVE AND AT THE DESCRIPTION OF THE DESCRIPTION FOR PRINCIPLE TRENCH BOTTOM MAY BE STABILIZED DRING A GEOTESTILE MATERIAL. BEDDING: SUITABLE MATERIAL SHALL BE CLASS LAND IL THE CONTRACTOR SHALL PROVIDE DOCUMENTATION FOR MATERIAL SPECIFICATION TO ENGINEER.
- 7. INITIAL BACKFILL: SUITABLE MATERIAL SHALL BE CLASS I OR I IN THE PIPE ZONE EXTENDING NOT LESS THAN 6" ABOVE CROWN OF FIRE-THE CONTRACTOR SHALL PROVIDE DOCUMENTATION FOR MATERIAL SPECIFICATION TO ENGINEER, MATERIAL SHALL BE INSTALLED AS REQUIRED IN ASTALL DAY.





53 North Main Street, Saite 20 Seillweter, Minnesota 55013 Phone (612) 309-3094 www.ericksoncivilsite.com

DRAWING PHASE: √ AGENCY REVIEW

BID DOCUMENT FOR CONSTRUCTION AS-BUILT DOCUMENT

THEREBY CERTIFY THAT THIS PLAN. SPECIFICATION OR REPORT WAS INSPANDED BY ME OR LINDER BY DIRECT SUPERVISION AND THAT LAWA DULY ILL CONSED PROFESSIONAL THE SECTION OF THE S TODO A ERICKSON, PE 40418

LICENSE NO 10/14/2015

HOM FURNITURE 10301 Woodcrest Drive NW Coon Rapids, Minnesota 55433

HOM FURNITURE 7800 Dupont Avenue South Bloomington, Minnesota



SHEET TITLE

DETAILS





Furniture

7800 Dupont Ave. S. Bloomington, Minnesota

	Revisions	
Item		Date
		=

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I hereby certify that this plan, specification, or report was prepared by me or under my direct supervision, and that I am a duly Licensed Architect under the laws of the State of Minnesota

Printed Name MICHAEL F. DIEM Signature

DATE License # 10-28-25 16844

Sheet Information SITE LANDSCAPING PLAN TREES

Drawing No:


Project No: 15-107

RIT Drawn By:


Checked By: MFD

11-03-15

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Furniture

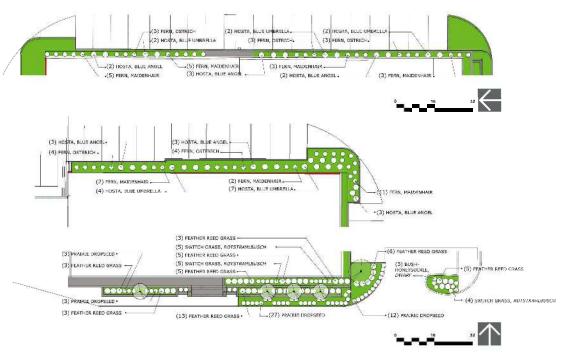7800 Dupont Ave. S. Bloomington, Minnesota

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Item		Date
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Printed Name MICHAEL F. DIEM Signature

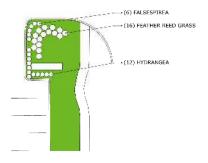DATE License # 10-28-25 16844

Sheet Information SITE LANDSCAPING PLAN SHRUBS

Project No: 15-107 Drawing No:

RIT Drawn By:

Checked By: MFD

11-03-15

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NORTH ELEVATION SCALE: 1"=30"



EXTERIOR BUILDING MATERIALS TO CONSIST OF THE FOLLOWING:

- A-METAL FASCIA PANELS
- B-PROFILED METAL PANELS
- c -STOREFRONT GLAZING
- D-METAL WALL PANELS (30 YEAR WARRANTY)
- **E-PROJECTING METAL SLATS**
- F-FINAL AREAS AND LOCATIONS TO BE DETERMINED IN SUBSEQUENT SUBMITTALS





NORTH EAST VIEW



NORTH WEST VIEW


10-15-2015

HOM BLOOMINGTON, MN



EXTERIOR BUILDING MATERIALS TO CONSIST OF THE FOLLOWING:

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- c -STOREFRONT GLAZING
- D-METAL WALL PANELS (30 YEAR WARRANTY)
- E -PROJECTING METAL SLATS
- F-FINAL AREAS AND LOCATIONS TO BE DETERMINED IN SUBSEQUENT SUBMITTALS

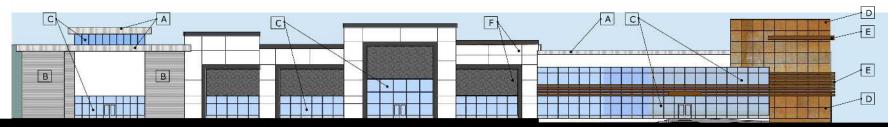

SOUTH ELEVATION SCALE: 1"=30"




SOUTH EAST VIEW SOUTH WEST VIEW

10-15-2015

POSSIBLE SIGNAGE AREA

NOT TO EXCEED 740 SQ .FT.

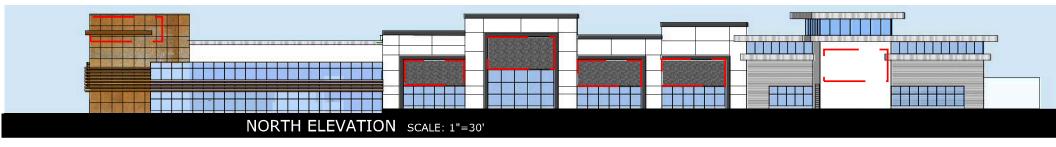

POSSIBLE SIGNAGE AREA

NOT TO EXCEED 688 SQ .FT.




SOUTH ELEVATION SCALE: 1"=30'

8-5-2015



SCALE: NTS BLOOMINGTON, MN

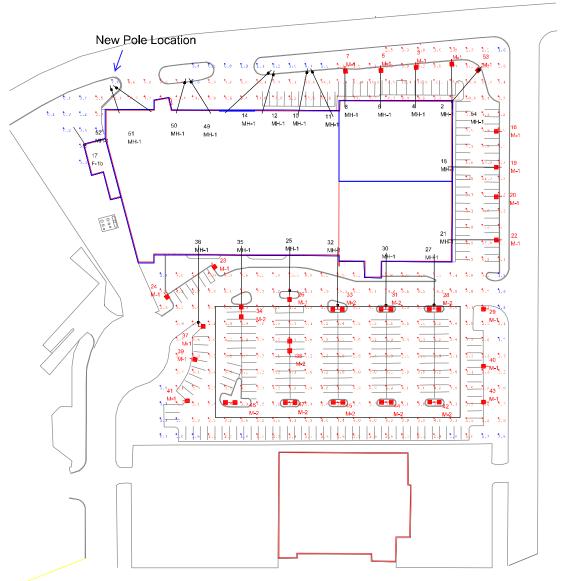

Luminaire Schedule									
Symbol	Qty	Label	Arrangement	Total Lamp Lumens	LLF	Description			
₩	1	F-1b	SINGLE	42000	0.300	Existing 400W MH Flood Horiz FG 15' Mtg Ht MPWR-65-X-400 (By Others)			
	18	M=1	SINGLE	17500	0.810	New Fixt w/250W PSMH T5 Vert FG 25' Mtg Ht Visionaire AMERICAN AME-2 T5-250 PS			
•	10	M-2	BACK-BACK	17500	0,810	New Fixt w/250W PSMH T5 Vert FG 25' Mtg Ht Visionaire AMERICAN AME-2 T5-250 PS			
	21	MH-1	SINGLE	82000	0.800	New Flood 750W FG 26' Mtg Ht Techlight DCL Series DCLBAP1			

Calculation Summary									
Label	Avg	Max	Min	Avg/Min	Max/Min	# Pts			
Site	4.83	19.8	0.0	N.A.	N.A.	357			
Main Parking	3.95	5.4	2.4	1.65	2.25	90			

On-Site Lighting

1111 HIGHWAY 25 NORTH SUITE 201 BUFFALO MN 55313

PH:763.684.1548

HOM FURNITURE

7800 DUPONT AVE. S. BLOOMINGTON, MN

IGINEER SEAL

	#	DATE	INET	DESCRIPTION
S	1	10.08.2015	BPJ	ADDED FIXTURES
SNO	2	10.09.2015	BPJ	CHANGE FIXTURE LOCATION
SI	3	10.12.2015	BPI	ADDED FIXTURES
æ				
Z				

METAL HALIDE PHOTOMETRIC PLAN

PROJECT :

BASED ON THE INFORMATION PROVIDED. ALL DIMENSIONS AND LUMINAIRE LOCATIONS SHOWN REPRESENT RECOMMENDED POSITIONS, THE ENGINEER AND/OR AND HITECT MUST DETERMINE APPLICABILITY OF THE LAYOUT TO EXISTING OR FUTURE FIELD CONDITIONS.

THE LIGHTING PATTERS REPRESENTS BLUMBATION LEVELS CALCILATED FROM MARKEN TOWN DAY TAKED LINGER THE CONTROLLED CONDITIONS OF TURNS CONDITIONS OF TURNS CONDITIONS OF TURNS CONDITIONS OF THE CONDITION OF THE CONDITION OF T

FOR ADDITIONAL LIGHTING INFORMATION CONTACT:

On-Site Lighting & Survey, LLC

PH: 763.684.1548


10.12.2015

B.JACOBS

SL200

REV#

SCALE: NTS BLOOMINGTON, MN

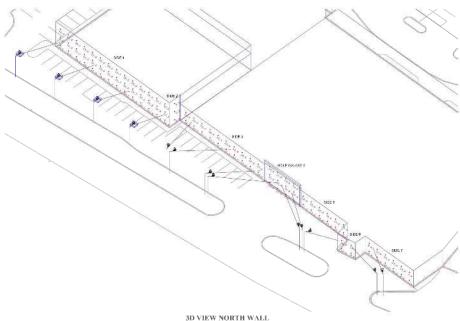

SIDE 1 SIDE 2 SIDE 3 GOLF GALAXY 4 SIDE 5 SIDE 6 SIDE 7

ELEVATION VIEW NORTH WALL

Luminsira Schedula								
Symbol	Oty	Label	Arrangement	Total Lamp Lumens	LLF	Description		
<u>+•</u>	4	M-1	SINGLE	17500	0.810	New Flst 250W PSMH T5 Vert FC 25 Mig Ht. Visionaire AMERICAN AVIE-2 T5-250 PS		
-0	13	MH-1	SINGLE	82000	0.800	New Flood 750W FG 26' Mtg Ht Techlight DCL Series DCLBAP1		

Label	Avg	Max	Min	Avg/Min	MaxiMin	# Pts
Sicie_1	12.93	19.6	8.7	1.49	2.25	42
Side_2	6.23	6.6	4.9	1.07	1.12	3
Side_3	13.57	17.4	10.6	1.28	1.64	20
Side_4	11.93	15.8	9.8	1.22	1.61	12
Side_5	12.73	16.0	9.2	1.38	1.74	12
Side_6	11,00	14.0	8.8	1.25	1.59	4
Side_7	11.37	21.0	3.4	3.34	6.18	12

BASED ON THE INFORMATION PHONDED, ALL DIMENSIONS AND LINTHAINS LOCATIONS SHEWN RETAINS THE COMMENCE PROSEDED HE THANK IT AND ADDITATION OF THE LANGUAR CONTINUE FIELD WAS DEFENDED. FOR THE LANGUAR CONTINUE FIELD WAS DEFENDED. THE CONTINUE FIELD WAS DEPOSITED WAS DEAD AS A CASE ADDITIONAL DEPOSITED WAS DEPOSITED. THE CONTINUE WAS DEPOSITED WAS DEPOSITED WAS DEPOSITED. THE CONTINUE WAS DEPOSITED WAS DEPOSITED. WAS DEPOSITED WAS DEPOSITED. WAS DEPOSITED WAS DEPOSITED.

On-Site Lighting & Survey, LLC

> 1111 HIGHWAY 25 NORTH SUTTE 201 BUFFALO MN 55313 PH:763.684.1548 FAX:763.682.9048

HOM FURNITURE

7800 DUPONT AVE. S. BLOOMINGTON, MN

* DATE INIT DESCRIPTION

1 1008-2015 INP MODERNATURE
2 1 1008-2015 INP MODERNATURE
3 1009-2015 INP MODERNATURE
4 1012-2015 INP MODERNATURES


METAL HALIDE NORTH WALL PHOTOMETRIC PLAN

PRO ...


10.08.2015

B.JACOBS SL.201

SCALE: NTS BLOOMINGTON, MN

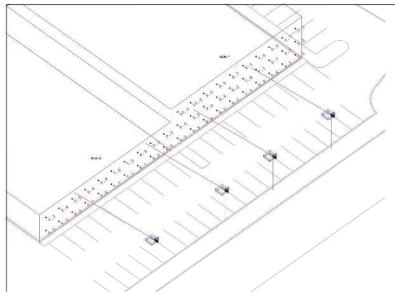


3D VIEW EAST WALL

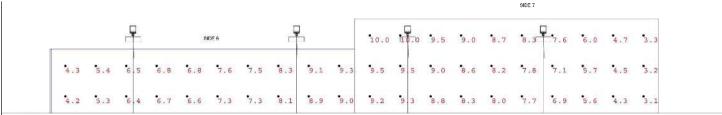

ELEVATION VIEW EAST WALL

Luminaire S	Luminaire Schedule								
Symbol	Symbol Qty Label Arrangement Total Lamp Lumens LLF					Description			
-	4	M-1	SINGLE	17500	0.810	New Fixt 250W PSMH TS Vert FG 25" Mtg Ht. Visionaire AMERICAN AME-2 T5-250PS			
	4	MH-1	SINGLE	82000	0.800	New Flood 750W FG 26' Mtg Ht Techlight DCL Series DCLBAP1			

Osloulation Summary									
Label	Avg	Mex	Min	AvgMin	Max/Min	#Pts			
Side_8	7.07	9.3	4.2	1.68	2.21	20			
Side_9	7,38	10.0	3.1	2,38	3,23	30			

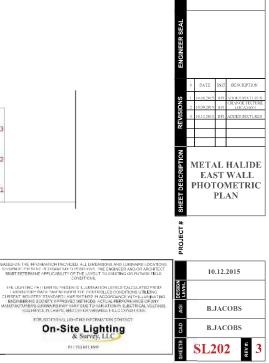

On-Site Lighting & Survey, LLC


> 111 HIGHWAY 25 NORTH SUITE 201 BUFFALO MN 58313

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HOM FURNITURE 7800 DUPONT AVE. S. BLOOMINGTON, MN

SCALE: NTS


BLOOMINGTON, MN

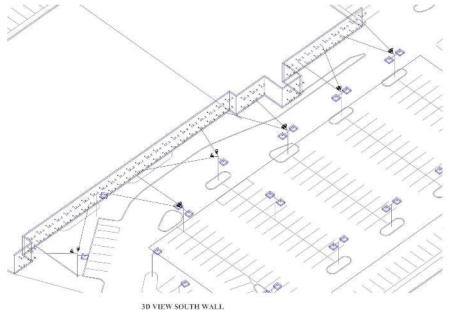

ELEVATION VIEW SOUTH WALL

Luninaire Schedule											
Symbol	Oty	Label	Arrangement	Total Lamp Lumens	LLF	Description					
-	3	M-1	SINGLE	17500	0.810	New Fixt w250W PSMH T5 Vert F3 25 Mig H: Visionaire AMERICAN AVIE-2 T5-250 PS					
1 ·	4	M-2	BACK-BACK	17500	0.810	New Fixt w/250W PSMH T5 Vert FG 25' Mtg Ht Visionaire AMERICAN AME-2 T5-250 PS					
	12	MH-1	SINGLE	82000	0.800	New Flood 750W FG 26' Mtg Ht Techlight DCL Series DCLBAP1					

Calculation Summary										
Label	Avg	Max	Min	Avg/Vin	MaxiMin	# Pts				
Side_1	13.12	15.0	9.9	1.33	1.52	18				
Side_2	15,75	17.9	12.7	1.24	1,41	4				
Side_3	11.17	13.1	7.9	1.41	1.66	6				
Side_4	12.53	19.0	10.2	1.23	1.86	46				
Side_5	10.20	13.3	7.8	1.31	1.71	4				

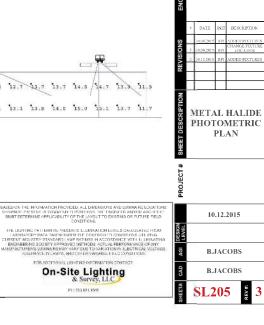

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